CS-10-179

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	CONTRACT MANAGEMENT
<u>CHANGE ORD</u>	ER APPROVAL FORM21 PH 12: 00
PROJECT:William Burgess Road Ext	CHANGE ORDER NUMBER:
	DATE:03/08/11
	CONTRACT NUMBER: CM1639
TO CONTRACTOR: Jacksonville Eighte	een Construction, Inc.
Reason for Change Order: Add inlet and manhole radated 02/28/11 (attached).	isers as detailed in Contractor's request for change order
Original Contract Sum Net Change by Previous Change Order/Supplement Contract Sum Prior to This Change Order	tal Agreement. \$ .00
Amount of This Change Order (Add/Deduct)	\$ 8,587.31
New Contract Sum Including this Change Order	\$960,007.86
The contract time for substantial completion will be	e ( <u>increased</u> ) ( <del>decreased</del> ) ( <del>unchanged</del> ) by 14 days; Substantial Completion 05/08/11; Final Completion 07/07/11
APPROVED BY: Project Manager (Department H	DATE: <u>-3/18/11</u>
APPROVED BY: Charlotte Your Contract Manager	DATE: 3/22/11
APPROVED BY: Director of Office of Manageme	DATE: 3.3/.1(2.29)
APPROVED BY: County Manager	ent & Budget DATE: $3/31/11$ - $3/31/111$ - $3/31/111$ - $3/31/111$ - $3/31/111$ - $3/31/111$ - $3/31/111$ - $3/31/111$ - $3/31/111$ - $3/31/111$ - $3/31/111$ - $3/31/111$ - $3/31/111$ - $3/31/111$ - $3/31/1111$ - $3/31/$

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Board of County Commissioners,	RECEIVED
Nassau County	2011 MAR 14 PM 1:48 Contractor
	Field 🗆
	Other 🗆
CHANGE ORDER REQUEST	
PROJECT: William Brugess Extension CHAN	
DAI	re: 03/03/1)
	NTRACT NUMBER: CM -1639
to contractor: Jacksonville Eig	
to contractor: <u>Dacesonnie</u> eig	
The Contract is changed as follows: C agree to amend the contract to a detailed in Jacksonville Eighteen Co Order dated 02/28/11 (attached). Original Contract Sum	s_951,420.55
Net change by Previous Change Order	ş <u>0.00</u>
Contract Sum Prior to This Change Orde	r \$ 951, 420.55
Amount of This Change Order (Add)Deduc	€) \$ <u>8,587.31</u>
New Contract Sum, Including this Chang Order	e <u>\$ 960,007.86</u>
The Contract Time for substantial ( <del>decreased</del> ) ( <del>unchanged)</del> by <b>fourteen (</b> 1	completion will be (increased) $4$ days.
This document, when signed by all part the Contract and all provisions of the RECOMMENDED BY: Resident Project Rep	Contract shall apply hereto.          Image: 103/03/11
ACCEPTED BY:	DATE: 3/8/2011
Approved by:	

с».

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Nassau County Project Manager

From:	Jonathan Page [jpage@nassaucountyfl.com]
Sent:	Thursday, March 03, 2011 8:16 AM
To:	Dutton, Greg
Cc:	Shelley Caldwell; Scott Herring; Jonathan Page
Subject:	FW: William Burgess: Drainage Pipe Issues
Attachments:	Change Order 02 - Inlet Risers.pdf

Importance:

High

Lots of issues here but I agree with your assessment to proceed asap with CO #2. That is only 4 of the issues.... The 14 days is another 8-10k of CEI time on top of that. So this is basically a 16-20k change order. Please track these error and omission change orders like we did Old Dixie, ok?

Jonathan Page, P.E.

Engineer III

Engineering Services Dept.

96161 Nassau Place

Yulee, FL 32097

(904) 491-7330

jpage@nassaucountyfl.com

From: Dutton, Greg [mailto:gdutton@wilbursmith.com]
Sent: Wednesday, March 02, 2011 4:28 PM
To: Jonathan Page
Cc: Dutton, Greg; Martin, Derrick R
Subject: William Burgess: Drainage Pipe Issues

Jonathan, this is to provide you with a summary of issues related to the drainage system installed at the William Burgess project. The drainage system has been checked and verified that it was installed according to the plans.

- 1. RFI No 09, Elevations of Inlet Structures S-2, S-5, S-7 and Manhole Structures S-3 and S-9A create a situation where the surrounding slopes are too steep adjacent to the sidewalk. It is a safety issue and the planned seed & mulch is not expected to take. Since we met at the project site and determined the most desirable, cost-effective and least disruptive solution to the schedule was to raise the inlet tops 9" and provide slots, Jax18 has provided us a cost (see attached) and revised the structure submittals. Nick has approved the submittals. The cost includes mobilizing the pipe crew, cutting down the existing installed inlets (the precast fabricator cannot provide 9" risers), installing 18" risers on the inlets (S-2, S-5, S-7), installing 20" manhole risers (S-3, S-9A), providing pinned sod, and markups. They have requested 14 days for the work. I have reviewed the proposed cost of \$8,587.31 and the 14 day time extension and found it to be reasonable. I recommend approval. If approved, I will process the change order asap.
- 2. RFI No 10, Pipe Run P-40 Cover Cross drain at US-17: The top of pipe is expected to be encroaching into the base. FDOT Index 205 requires a minimum 7" cover between the top of pipe and the bottom of the base.

2/28/2011



#### Request For Change Order

TO: Wilbur Smith Associates	FROM: Jacksonville Eighteen Construction, Inc.
ATTN: Greg Dutton	Evan Lawrence
Fax:	Fax: (904) 810-2323
Phone: (904) 781-8131	Phone: (904) 810-1925
E-mail: <u>gdutton@wilbursmith.com</u>	E-mail: <u>evan@jax18.com</u>
Date: Monday, February 28, 2011	Page 1 of 2

### Re: William Burgess Blvd. Extension

Request For Change Order No. 2

Add Inlet and Manhole Risers

#### 2/28/2011

#### Re: William Burgess Blvd. Extension

#### Request For Change Order No. 2

#### Add Inlet and Manhole Risers

As requested we have prepared a proposed Change Order No. 2 for the William Burgess Extension. Our proposal includes all necessary labor, equipment and materials to complete the following task: <u>Add inlet and manhole risers.</u>

This is a Lump Sum proposal of work. All work will be preformed to Standards and Specifications as outlined in the contract documents. Proposal includes the cost to cut S-02, S-05 and S-07, 9" from existing top elevation and Install 18" risers with orifices cut in the East and West sides of the box. Orifices will be 5" high by 36"wide with a rise of 9" from the bottom of the riser. Proposal also includes the cost to add 20" Manhole risers to S-03 and S-09A to match the proposed sidewalk elevations at these locations. Sod will need to be installed 50' east and west of each inlet location from the back of the side walk to the R/W line as permanent erosion control in these areas.

Description	Quantity	Unit	Unit Price	Total
Mobilization	1	LS		\$ 1,451.33
Cut Inlets (S-02, S-05, S-07)	3	Ea	\$ 253.84	\$ 761.52
18" E inlet Risers Labor and Equipment	3	Ea	\$ 829.83	\$ 2,489.49
(S-02, S-05, S-07)				
18" E inlet Risers Material	3	Ea	\$ 179.26	\$ 537.78
(S-02, S-05, S-07)				
20" Manhole Risers Labor and	2	Ea	\$ 752.06	\$ 1,504.12
Equipment (S-03, S-09A)				
20" Manhole Riser Material (S-03)	1	Ea	\$ 135.80	\$ 135.80
20" Manhole Riser Material (S-09A)	1	Ea	\$ 206.42	\$ 206.42
Pinned Sod (Back of S/W to R/W Line)	167	Sy	\$ 2.28	\$ 380.76
Contractor Overhead and Profit	1	LS		\$ 1,120.08
Lumn Sum				\$ 8 587 31

(EIGHT THOUSAND FIVE HUNDRED EIGHTY-SEVEN DOLLARS AND THIRTY-ONE CENTS)

Total calendar days for this change:

14 Days Requested

(Days Requested are from the Date of Approval)

Reason for Extension of Time: Additional time will be required for the manufacturing of the risers from the Precast supplier. We will then need to Re-Mobilize our pipe crew and equipment to the job site and perform the work. Structures S-02,05 and 07 will have to be cut to grade, new risers installed and backfilled to the proposed elevations.

We appreciate the opportunity to submit this proposal. If you have any questions, please let me know. If this change is approved, please issue a change order to our contract.

Sincerely,

Evan Lawrence Jacksonville Eighteen Construction, Inc.

> Jacksonville Eighteen Construction, Inc. Page 2 of 2 345 Cumberland Industrial Court, Bldg. # A • St. Augustine, Florida • 32095 Jacksonville Telephone - (904) 260-6393 • St. Augustine Telephone - (904) 810-1925 Jacksonville Fax - (904) 338-0226 • St. Augustine Fax - (904) 810-2323

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#### **Evan Lawrence**

Don Whitford [don.whitford@dsuprecast.com] From: Monday, February 28, 2011 8:31 AM Sent: Evan Lawrence To: Re: William Burgess Boulevard - risers Subject: S-02, S-05, S-07 risers = \$165.00 each S-03 riser = \$125.00 S-09A riser = \$190 TOTAL = \$810.00 Don Whitford Dura-Stress Underground, Inc. work: 800.762.3520 fax: 352.787.4011 On 2/25/2011 2:08 PM, Evan Lawrence wrote: > > Don, Thanks for your quick response, the revisions look good. Do you > have Pricing together on this yet? > > Evan Lawrence > Jacksonville Eighteen Construction, Inc. > Phone: (904) 810-1925 > Fax: (904) 810-2323 > evan@jax18.com > > ----Original Message-----> From: barry > Sent: Friday, February 25, 2011 10:08 AM > To: Evan Lawrence > Subject: FW: William Burgess Boulevard - risers > > > > ----Original Message-----> From: Don Whitford [mailto:don.whitford@dsuprecast.com] > Sent: Friday, February 25, 2011 9:42 AM > To: barry > Subject: William Burgess Boulevard - risers > > Barry, > > Attached are shop drawings of the risers requested for William Burgess > Boulevard. Please verify that they are correct and contact me to > proceed with production. > > ~Don > > > --> Don Whitford > Dura-Stress Underground, Inc. > work: 800.762.3520 fax: 352.787.4011

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From:	Evan Lawrence [evan@jax18.com]
Sent:	Friday, February 25, 2011 10:44 AM
То:	Dutton, Greg
Cc:	Nick Gillette; Martin, Derrick R; jpage@nassaucountyfl.com; Eddie
Subject:	E-inlet risers
Attachments:	2010-09-101_risers.pdf

After discussing this w/ my precast supplier, a 9" riser with a 5"x 36" slot will not work. The riser will need to be a minimum of 18" for structural reasons.

What we are proposing to do is Build the risers 18" with a 5" x 36" slot cut in the riser 9" from the bottom. For this to work, we will have to cut down the existing box 9" then set the riser. This will make the bottom of the 5" slot match the existing top elevation of the box and raise the new top elevation to 9" above existing elevation.

- 22


The lead time on the risers will be 1 week, plus time to cut the existing box and set the new risers. Because this item is critical to grading the ditches and sidewalk we are asking for a 14 day time extension for this change if approved.


Please advise.

Evan Lawrence



Phone: (904) 810-1925 Fax: (904) 810-2323 evan@jax18.com

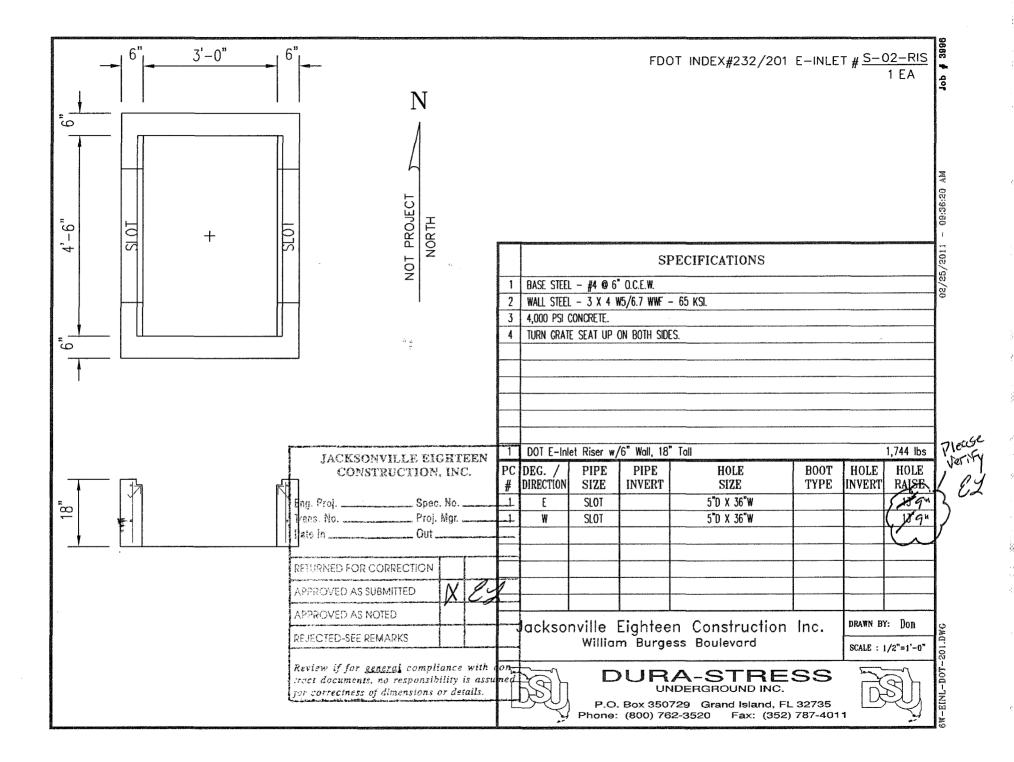

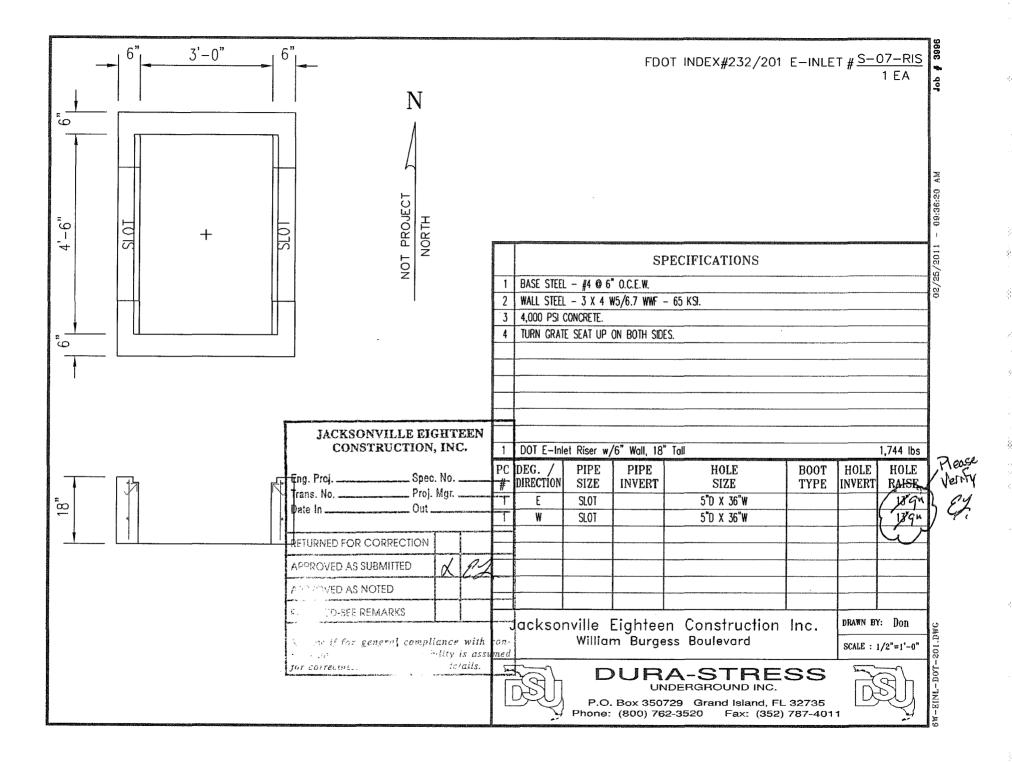

From: Sent: To: Cc: Subject: Martin, Derrick R Thursday, February 24, 2011 2:32 PM Evan Lawrence Dutton, Greg; jpage@nassaucountyfl.com William Burgess Manhole S-3 and S-9B Tops

Evan, Robert and I were just looking at the items to be completed tomorrow and noticed that the manhole tops will need to be raised approximately 21-22 inches to be on grade with the sidewalk. Section 201, sheet 2 of 5 note 5 of the Standard index reads "Frames may be adjusted a MAXIMUM 12" height with brick or precast ASTM C478 grade rings". These manhole structures are S-9A Sta 13+90 and S-3 Sta 22+80. Please advise. Thank you.

Derrick R. Martin

Senior Inspector

Wilbur Smith Associates

(O) 904-781-8131 (M) 912-288-4717

drmartin@wilbursmith.com

From: Sent: To: Cc: Subject: Nick Gillette [Nick@gilletteassociates.com] Friday, February 25, 2011 9:47 AM Evan Lawrence Dutton, Greg RE: Relocation of P-40

Evan,

Please make the invert at elevation 30.7 for pipe P-40. I showed a flat run and I believe you sloped the run, so the highest invert should be elevation 30.7.

Thanks.

Nick E. Gillette, P.E. Principal/Engineer 20 South 4th Street Fernandina Beach, FL 32034 (904) 261-8819 (P) (904) 261-9905 (F)

From: Evan Lawrence [mailto:evan@jax18.com] Sent: 2011-02-24 4:10 PM To: Nick Gillette Subject: RE: Relocation of P-40

Nick, if you could issue new invert elevations for P-40 as the answer to the corresponding RFI that would be helpful to us.

Evan Lawrence


Jacksonville Eighteen Construction, Inc. Phone: (904) 810-1925 Fax: (904) 810-2323 evan@jax18.com

From: Nick Gillette [mailto:Nick@gilletteassociates.com] Sent: Thursday, February 24, 2011 1:04 PM To: Evan Lawrence Subject: Relocation of P-40

Evan,

Do you need anything from me on this or are you just lowering the pipe where the finished grade over the pipe (with the requisite 7" of cover) matches the edge of pavement grade at US 17?

Nick E. Gillette, P.E. Principal/Engineer 20 South 4th Street Fernandina Beach, FL 32034 (904) 261-8819 (P) (904) 261-9905 (F)

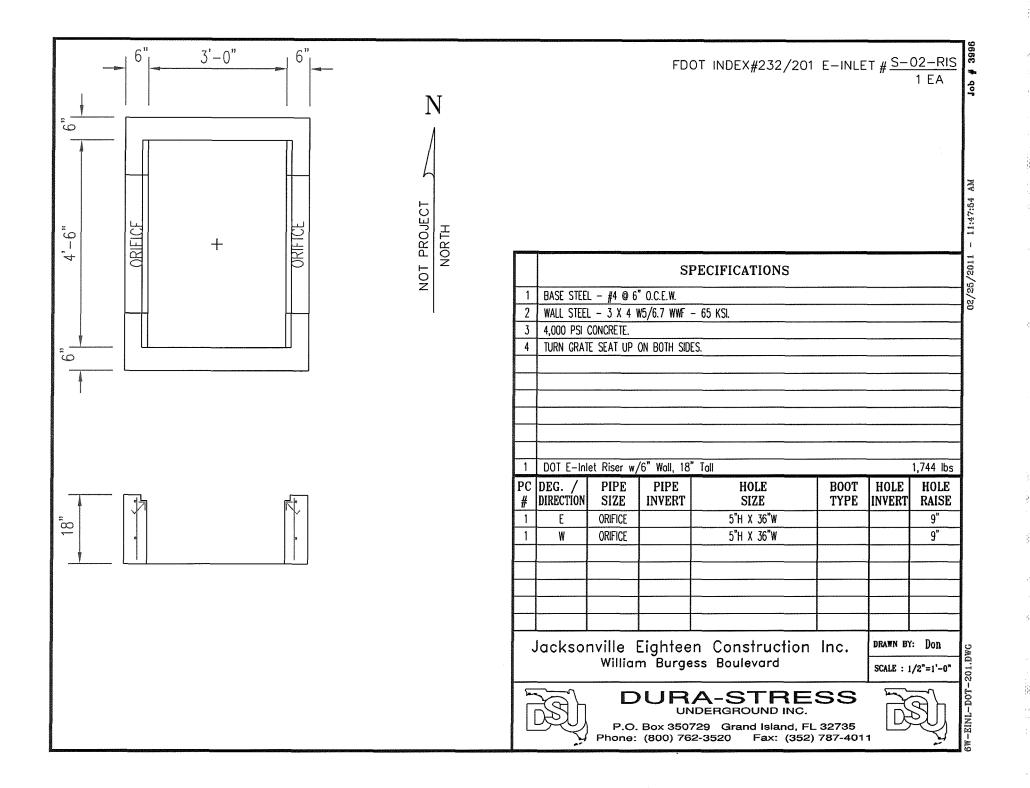

48" DIA. STORM MANHOLE  $\# \frac{S-03-RIS}{1 EA}$ 

# 11:47:54 AM 02/25/2011

399

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#### SPECIFICATIONS

BASE STEEL - #4 @ 9" O.C.E.W. w/ PERIPHERAL REINFORCEMENT IN LIEU OF HOOKED ENDS. 1

#### 2 WALL STEEL - ASTM C-478.

TOP SLAB STEEL - #6 @ 6" O.C.E.W. w/ 6 EA. #8 DIAG. BARS AROUND OPENING. 3

4 4,000 PSI CONCRETE, TYPE II CEMENT.


20, 5" 48"ø

> 1 EA ~ ConWrap,CS-212,6"Wide,50'Roll 16 EA ~ JointWrap,Ramnek,1-1/2",Piece


5	NON-PENET	rating lift	HOLES.		*****		
	<u> </u>						
				·······			
1	48"Ø Rise	er w/5" Wal	l, 20" Tall	·····			1,428 lbs
PC #	DEG. / DIRECTION	PIPE SIZE	PIPE INVERT	HOLE SIZE	BOOT TYPE	HOLE INVERT	HOLE RAISE
						}}	
							·
	Jacksonville Eighteen Construction Inc. DRAWN BY: Don						
	William Burgess Boulevard SCALE : 3/8"=1'-0"						
	William Burgess Boulevard SCALE : 3/8"=1'-0" DURA-STRESS UNDERGROUND INC. P.O. Box 350729 Grand Island, FL 32735 Phone: (800) 762-3520 Fax: (352) 787-4011						





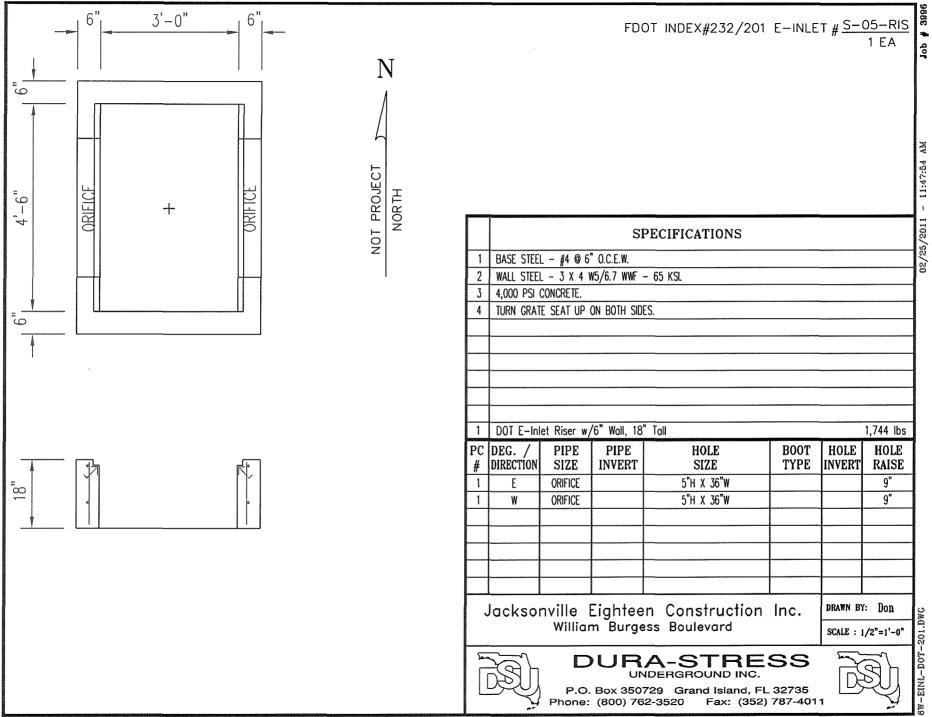

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60" DIA. STORM MANHOLE #S-09A-RIS ¶ dol 1 E A
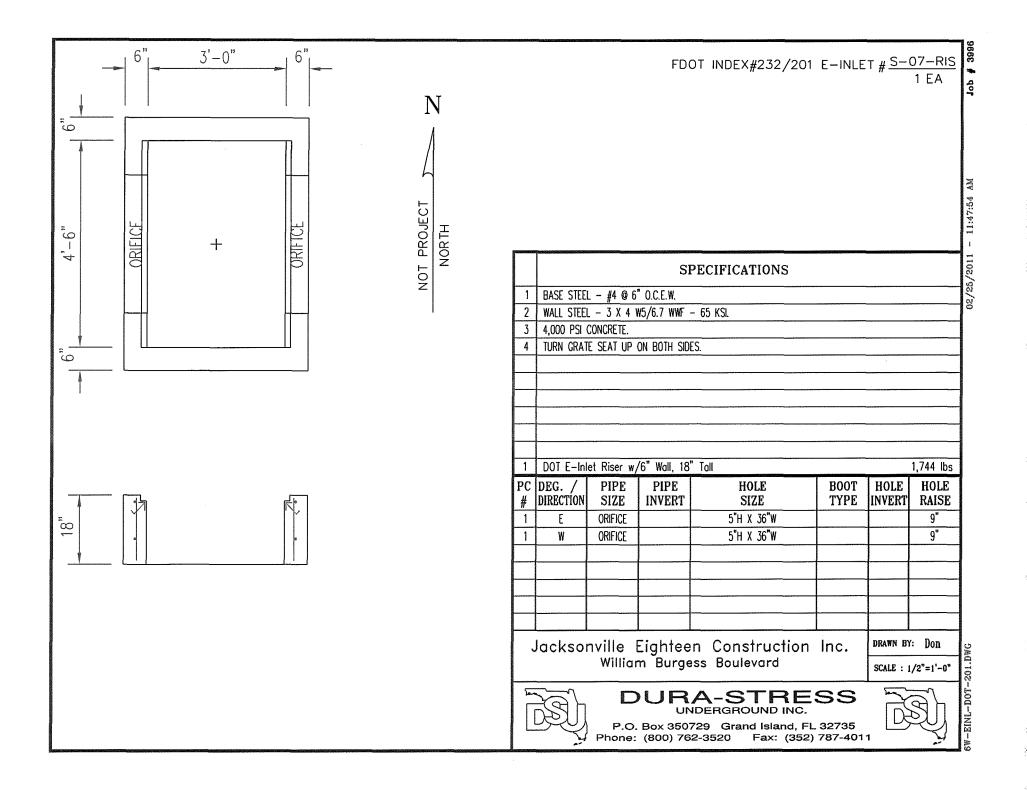
## 11:47:54 02/25/2011

HOLE

SIZE

DURA-STRESS UNDERGROUND INC.

P.O. Box 350729 Grand Island, FL 32735

Phone: (800) 762-3520 Fax: (352) 787-4011

BOOT

TYPE

HOLE

INVERT

DRAWN BY: Don

BASE STEEL - #5 @ 9" O.C.E.W. w/ HOOKED ENDS 1-1/2" CLEARANCE INSIDE FACE.

WALL STEEL – ASTM C-478. 2

TOP SLAB STEEL - #5 @ 9" O.C.E.W. w/ 6 EA. #6 DIAC. BARS AROUND OPENING. 3

4,000 PSI CONCRETE, TYPE II CEMENT. 4

60"Ø Riser w/6" Wall, 20" Tall

PIPE

SIZE

PIPE

INVERT

Jacksonville Eighteen Construction Inc. William Burgess Boulevard

NON-PENETRATING LIFT HOLES. 5

	PC #	DEG. / DIRECTION
6" 60"ø		
		·
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1 EA ~ ConWrap,CS-212,6"Wide,50'Roll 20 EA ~ JointWrap,Ramnek,1-1/2",Piece

20,

360X-24E-D-STD.DW SCALE : 3/8"=1'-0"

2,133 lbs

HOLE

RAISE